

GRIFFCO

1701 BARRETT LAKES BLVD.
SUITE 285
KENNESAW, GA 30144
PHONE: (770) 422-5420




11/10/2022

Copyright of Griffco Design/Build Inc. This drawing is the property of Griffco Design/Build Inc. and is submitted in confidence. Any unauthorized use is strictly not permitted.




INDIAN CREEK STUDIOS STAGE BUILDING D

3963 REDAN ROAD,
DEKALB COUNTY, GA

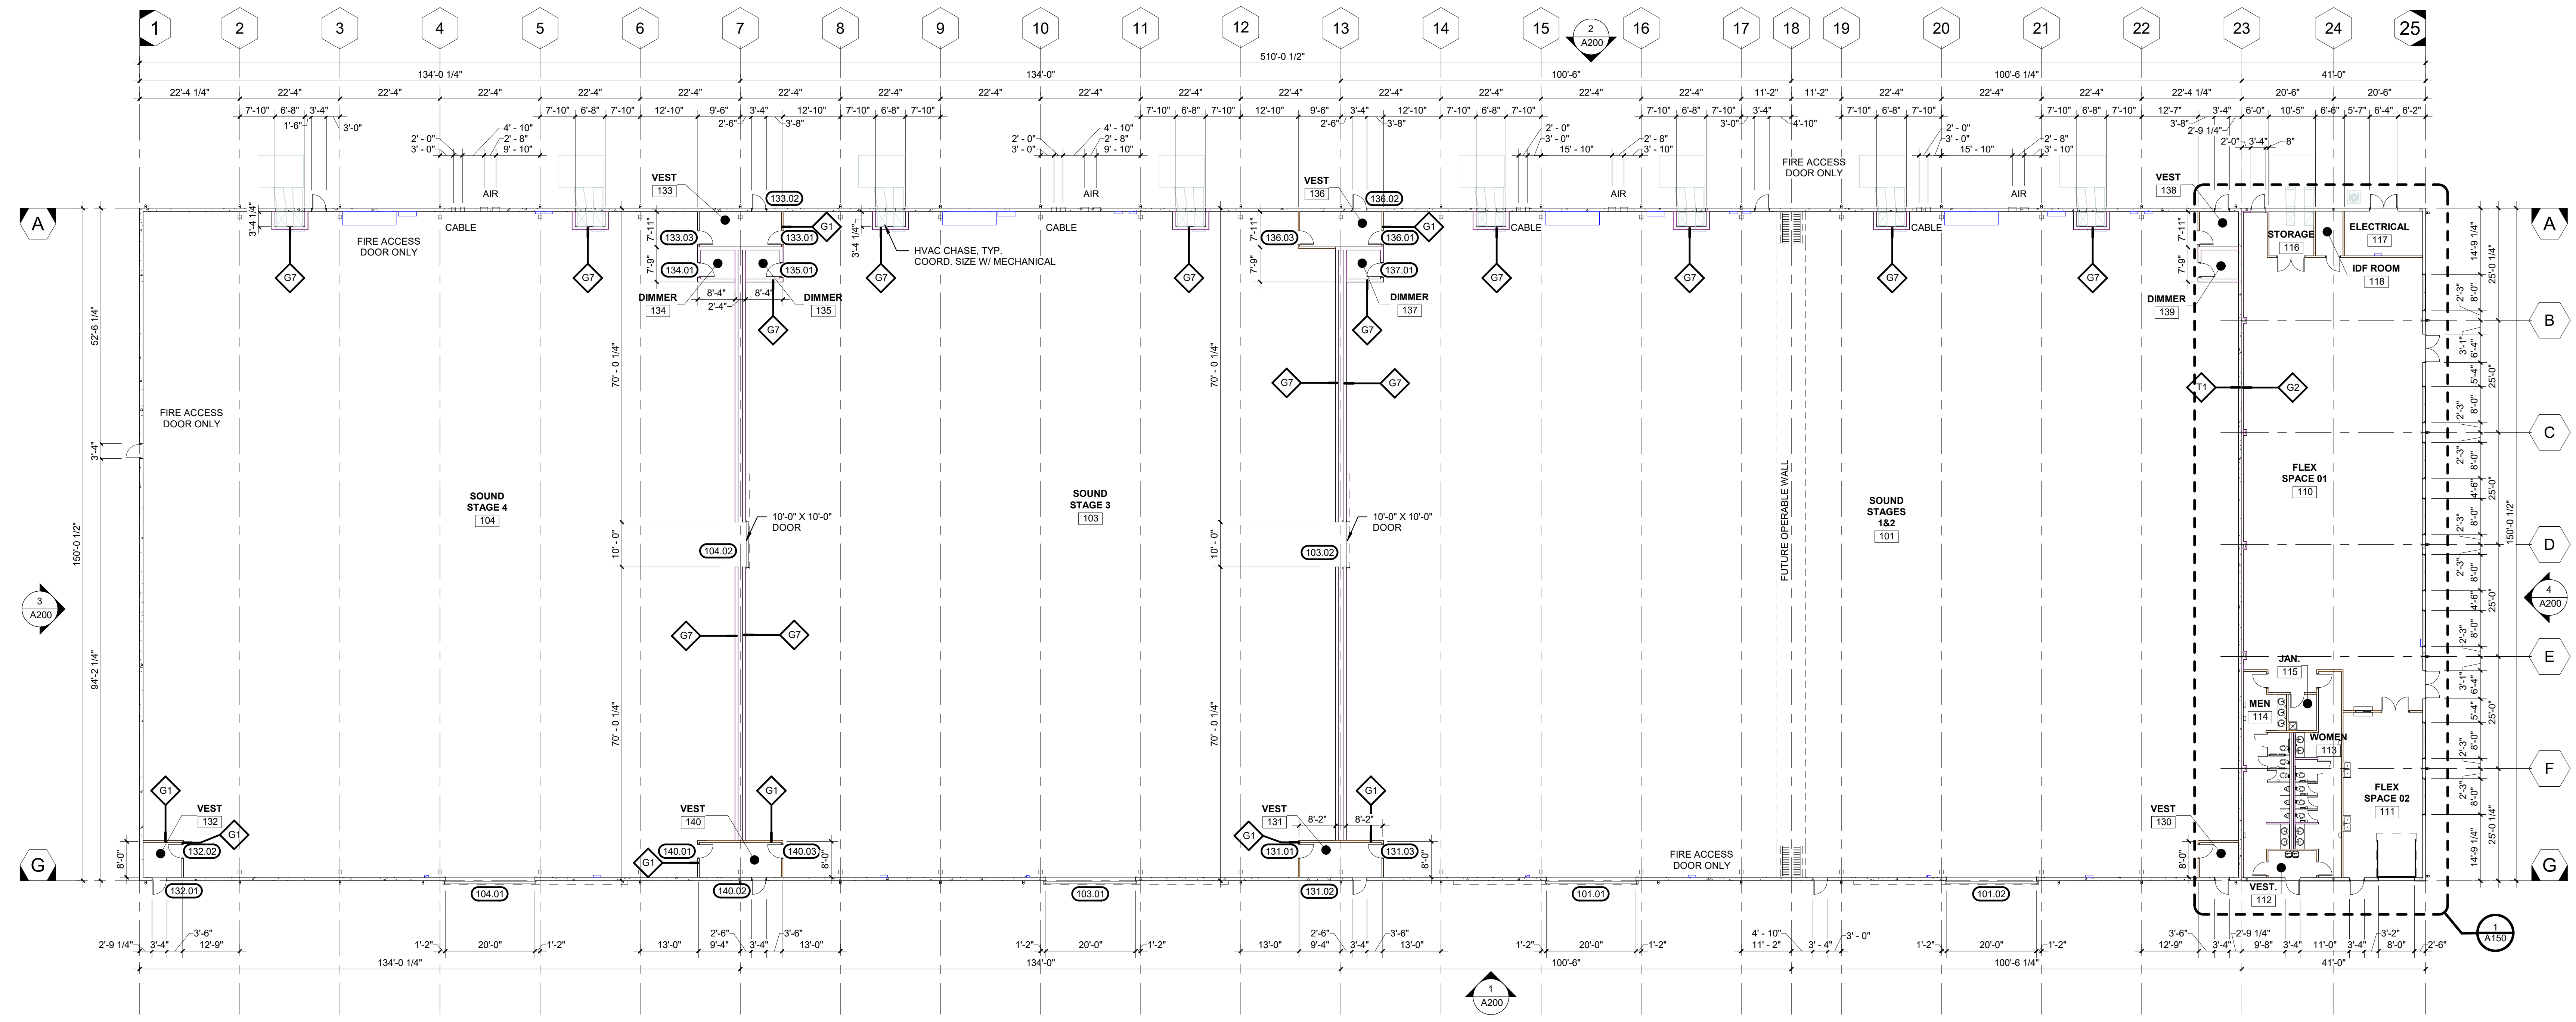

1 OVERALL FLOOR PLAN
A100 SCALE: 1/16" = 1'-0"

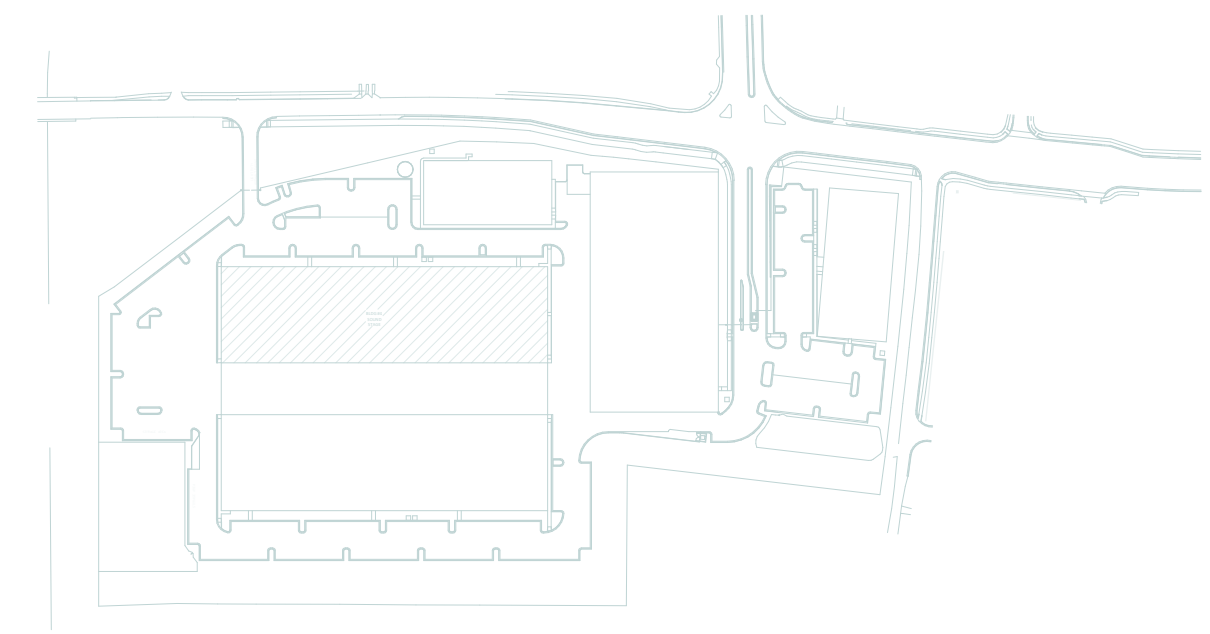

KEY PLAN

 HEAD: METAL STUD TRACK, 5/8" GYPSUM BOARD EACH SIDE BASE: RESILIENT BASE SEE FINISH SCHEDULE, METAL STUD RUNNER TRACK ANCHORED TO SLAB AT MAX. 16" O.C. PLAN: SOUND BATT INSULATION AS INDICATED ON PLANS, "C" SHAPED METAL STUD AT MAX. 16" O.C., 5/8" GYPSUM BOARD EACH SIDE	 HEAD: METAL STUD TRACK, 5/8" GYPSUM BOARD FINISH SIDE, SOUND BATT INSULATION AS INDICATED ON PLANS BASE: RESILIENT BASE SEE FINISH SCHEDULE, METAL STUD RUNNER TRACK ANCHORED TO SLAB AT MAX. 16" O.C. PLAN: "C" SHAPED METAL STUD AT MAX. 16" O.C., BATT INSULATION MIN. R-13, 5/8" GYPSUM BOARD FINISH SIDE	 HEAD: METAL STUD TRACK, 5/8" GYPSUM BOARD EACH SIDE BASE: RESILIENT BASE SEE FINISH SCHEDULE, METAL STUD RUNNER TRACK ANCHORED TO SLAB AT MAX. 16" O.C. PLAN: "C" SHAPED METAL STUD AT MAX. 16" O.C., 5/8" GYPSUM BOARD EACH SIDE	 HEAD: METAL STUD TRACK, 5/8" GYPSUM BOARD FINISH SIDE BASE: RESILIENT BASE SEE FINISH SCHEDULE, METAL STUD RUNNER TRACK ANCHORED TO SLAB AT MAX. 16" O.C. PLAN: "C" SHAPED METAL STUD AT MAX. 16" O.C., 5/8" GYPSUM BOARD FINISH SIDE	 HEAD: METAL STUD RUNNER TRACK BRACE TO STRUCTURE AT 48" O.C., REFER TO REFLECTED CEILING PLAN FOR CEILING TYPE AND HEIGHT BASE: RESILIENT BASE SEE FINISH SCHEDULE, METAL STUD RUNNER TRACK ANCHORED TO SLAB AT MAX. 16" O.C. PLAN: "C" SHAPED METAL STUD AT MAX. 16" O.C., 5/8" GYPSUM BOARD EACH SIDE	 HEAD: METAL STUD RUNNER TRACK BRACE TO STRUCTURE AT 48" O.C., REFER TO REFLECTED CEILING PLAN FOR CEILING TYPE AND HEIGHT BASE: RESILIENT BASE SEE FINISH SCHEDULE, METAL STUD RUNNER TRACK ANCHORED TO SLAB AT MAX. 16" O.C. PLAN: "C" SHAPED METAL STUD AT MAX. 16" O.C., 5/8" GYPSUM BOARD FINISH SIDE	 HEAD: METAL STUD TRACK, 5/8" GYPSUM BOARD FINISH SIDE, SOUND BATT INSULATION AS INDICATED ON PLANS BASE: RESILIENT BASE SEE FINISH SCHEDULE, METAL STUD RUNNER TRACK ANCHORED TO SLAB AT MAX. 16" O.C. PLAN: "C" SHAPED METAL STUD AT MAX. 16" O.C., BATT INSULATION MIN. R-13, 5/8" GYPSUM BOARD FINISH SIDE	 T1 9" CONCRETE TILT-UP WALL PANEL PLAN: CONCRETE TILT-UP WALL
PARTITION TYPE "G1" PARTITION TYPE "G2" PARTITION TYPE "G3" PARTITION TYPE "G4" PARTITION TYPE "G5" PARTITION TYPE "G6" PARTITION TYPE "G7" PARTITION TYPE "T1"							

PERMIT	02/22/22
COMMENTS	06/23/22
COMMENTS	08/23/22
ELEC COORD	09/09/22

JOB NUMBER: 2021-277

OVERALL FLOOR PLAN

SHEET NUMBER: A100